

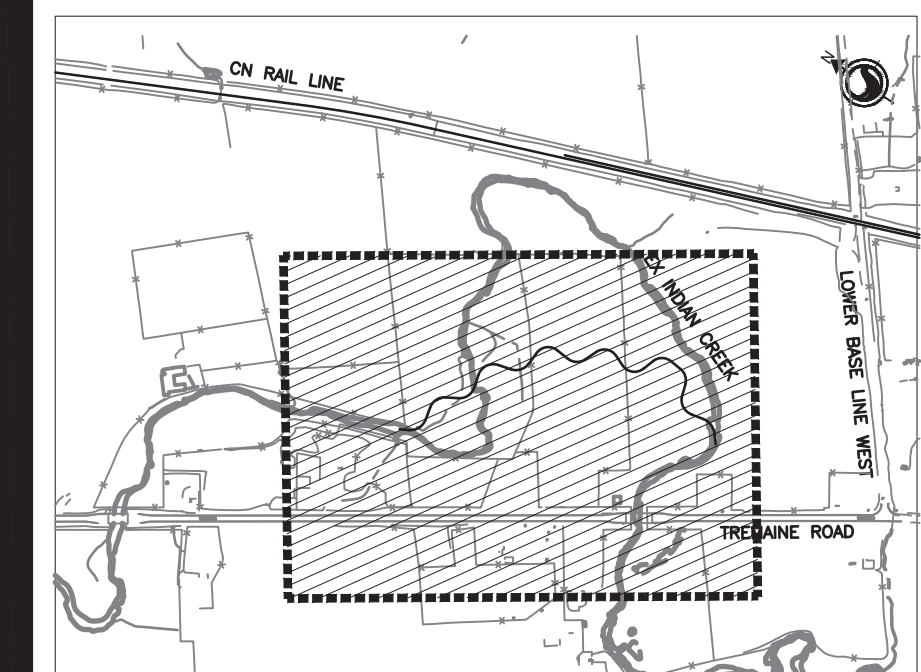


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Notes
 1. BENCHMARK: ELEVATIONS ARE GEODETIC (CGVD 1928: 1978 ADJUSTMENT), DERIVED BY DIFFERENTIAL GPS OBSERVATIONS.
 PROJECTION: UNIVERSAL TRANSVERSE MERCATOR (UTM, ZONE 17, CMB1'00"W)
 DATUM: NAD 83 (CSRS)
 2. ORIGINAL GROUND TOPOGRAPHY BASED ON LIDAR SURVEY RECEIVED (NOV. 2014) AND SUPPLEMENTED BY STANTEC CONSULTING (MAY 2014, AUG. 2014 & JUNE 2015)

Key Map NTS.



- Legend**
- LIMIT OF CONSTRUCTION
 - SWALE
 - COIR MATTING
 - JUTE MATTING
 - STRAW MATTING
 - CONSTRUCTION ENTRANCE
 - RIp RAP
 - ROCK CHECK DAM
 - SILT FENCE
 - SNOW FENCE
 - SHORT TERM TREE PROTECTION
 - LONG TERM TREE PROTECTION

0	ISSUED FOR CONSTRUCTION	HA	HA	2021.07.30
Revision		By	Appd	YYYY.MM.DD
File Name:	160960844_C-601EC			2021.03.05
		Dwn.	Chkd.	Dsgn.
				YY.MM.DD

Permit-Seal

ISSUED FOR CONSTRUCTION

Client/Project
 CANADIAN NATIONAL RAILWAY

MILTON LOGISTICS HUB - NATURAL CHANNEL DESIGN FOR INDIAN CREEK AND TRIBUTARY A
 Milton, ON

Title
 INDIAN CREEK
 SEDIMENT AND EROSION
 CONTROL PLAN

Project No. 160960844
 Scale 1:1000
 Revision 0
 Sheet 14 of 29
 Drawing No. 01-C-601



NOTES:
 1. APPLY STRAW MULCH AND SEED TO ALL DISTURBED AREAS THAT DO NOT HAVE MATTING PROTECTION.
 2. CONTRACTOR TO DEVELOP SITE ACCESS AND STAGING PLAN.

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ORIGINAL SHEET - ARCH D



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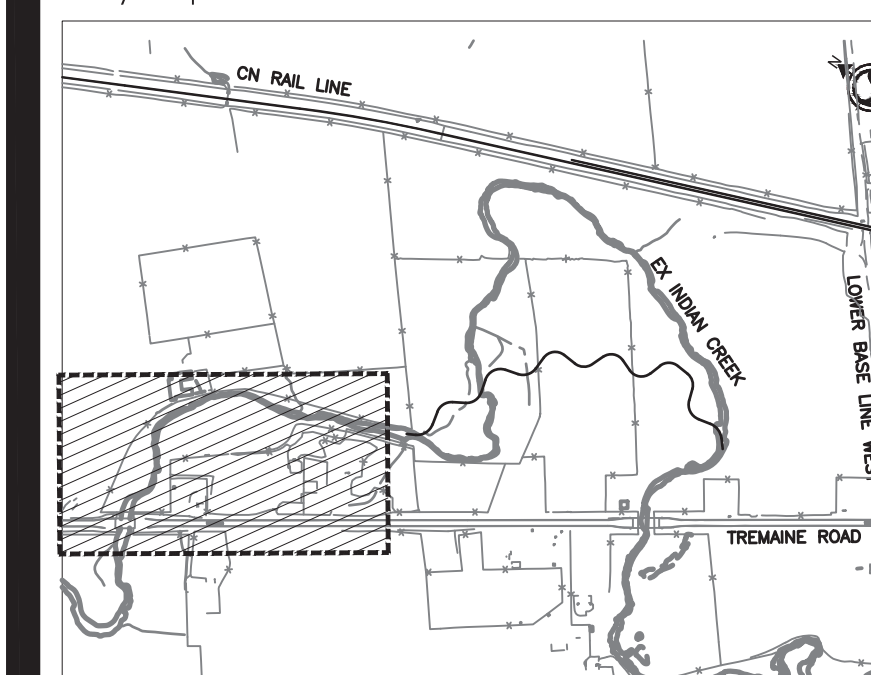
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Notes

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 PROJECTION: UNIVERSAL TRANSVERSE MERCATOR (UTM, ZONE 17, CMB1'00'W)
 DATUM: NAD 83 (CSRS)
- ORIGINAL GROUND TOPOGRAPHY BASED ON LIDAR SURVEY RECEIVED (NOV. 2014) AND SUPPLEMENTED BY STANTEC CONSULTING (MAY 2014, AUG. 2014 & JUNE 2015)

Key Map NTS.



Legend

- LIMIT OF CONSTRUCTION
- SWALE
- NO STRIPPING
- TREE REMOVAL
- EROSION CONTROL BLANKET
- CONSTRUCTION ENTRANCE
- SILT FENCE
- SNOW FENCE
- SHORT TERM TREE FENCE
- LONG TERM TREE FENCE
- SEDIMENT BASIN SLOPES

0	ISSUED FOR CONSTRUCTION	HA	HA	2021.07.30
Revision		By	Appd	YYYY.MM.DD

File Name:	160960844_C-602EC	Dwn.	Chkd.	Dgn.	2021.02.12
					YY.MM.DD

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Client/Project
 CANADIAN NATIONAL RAILWAY

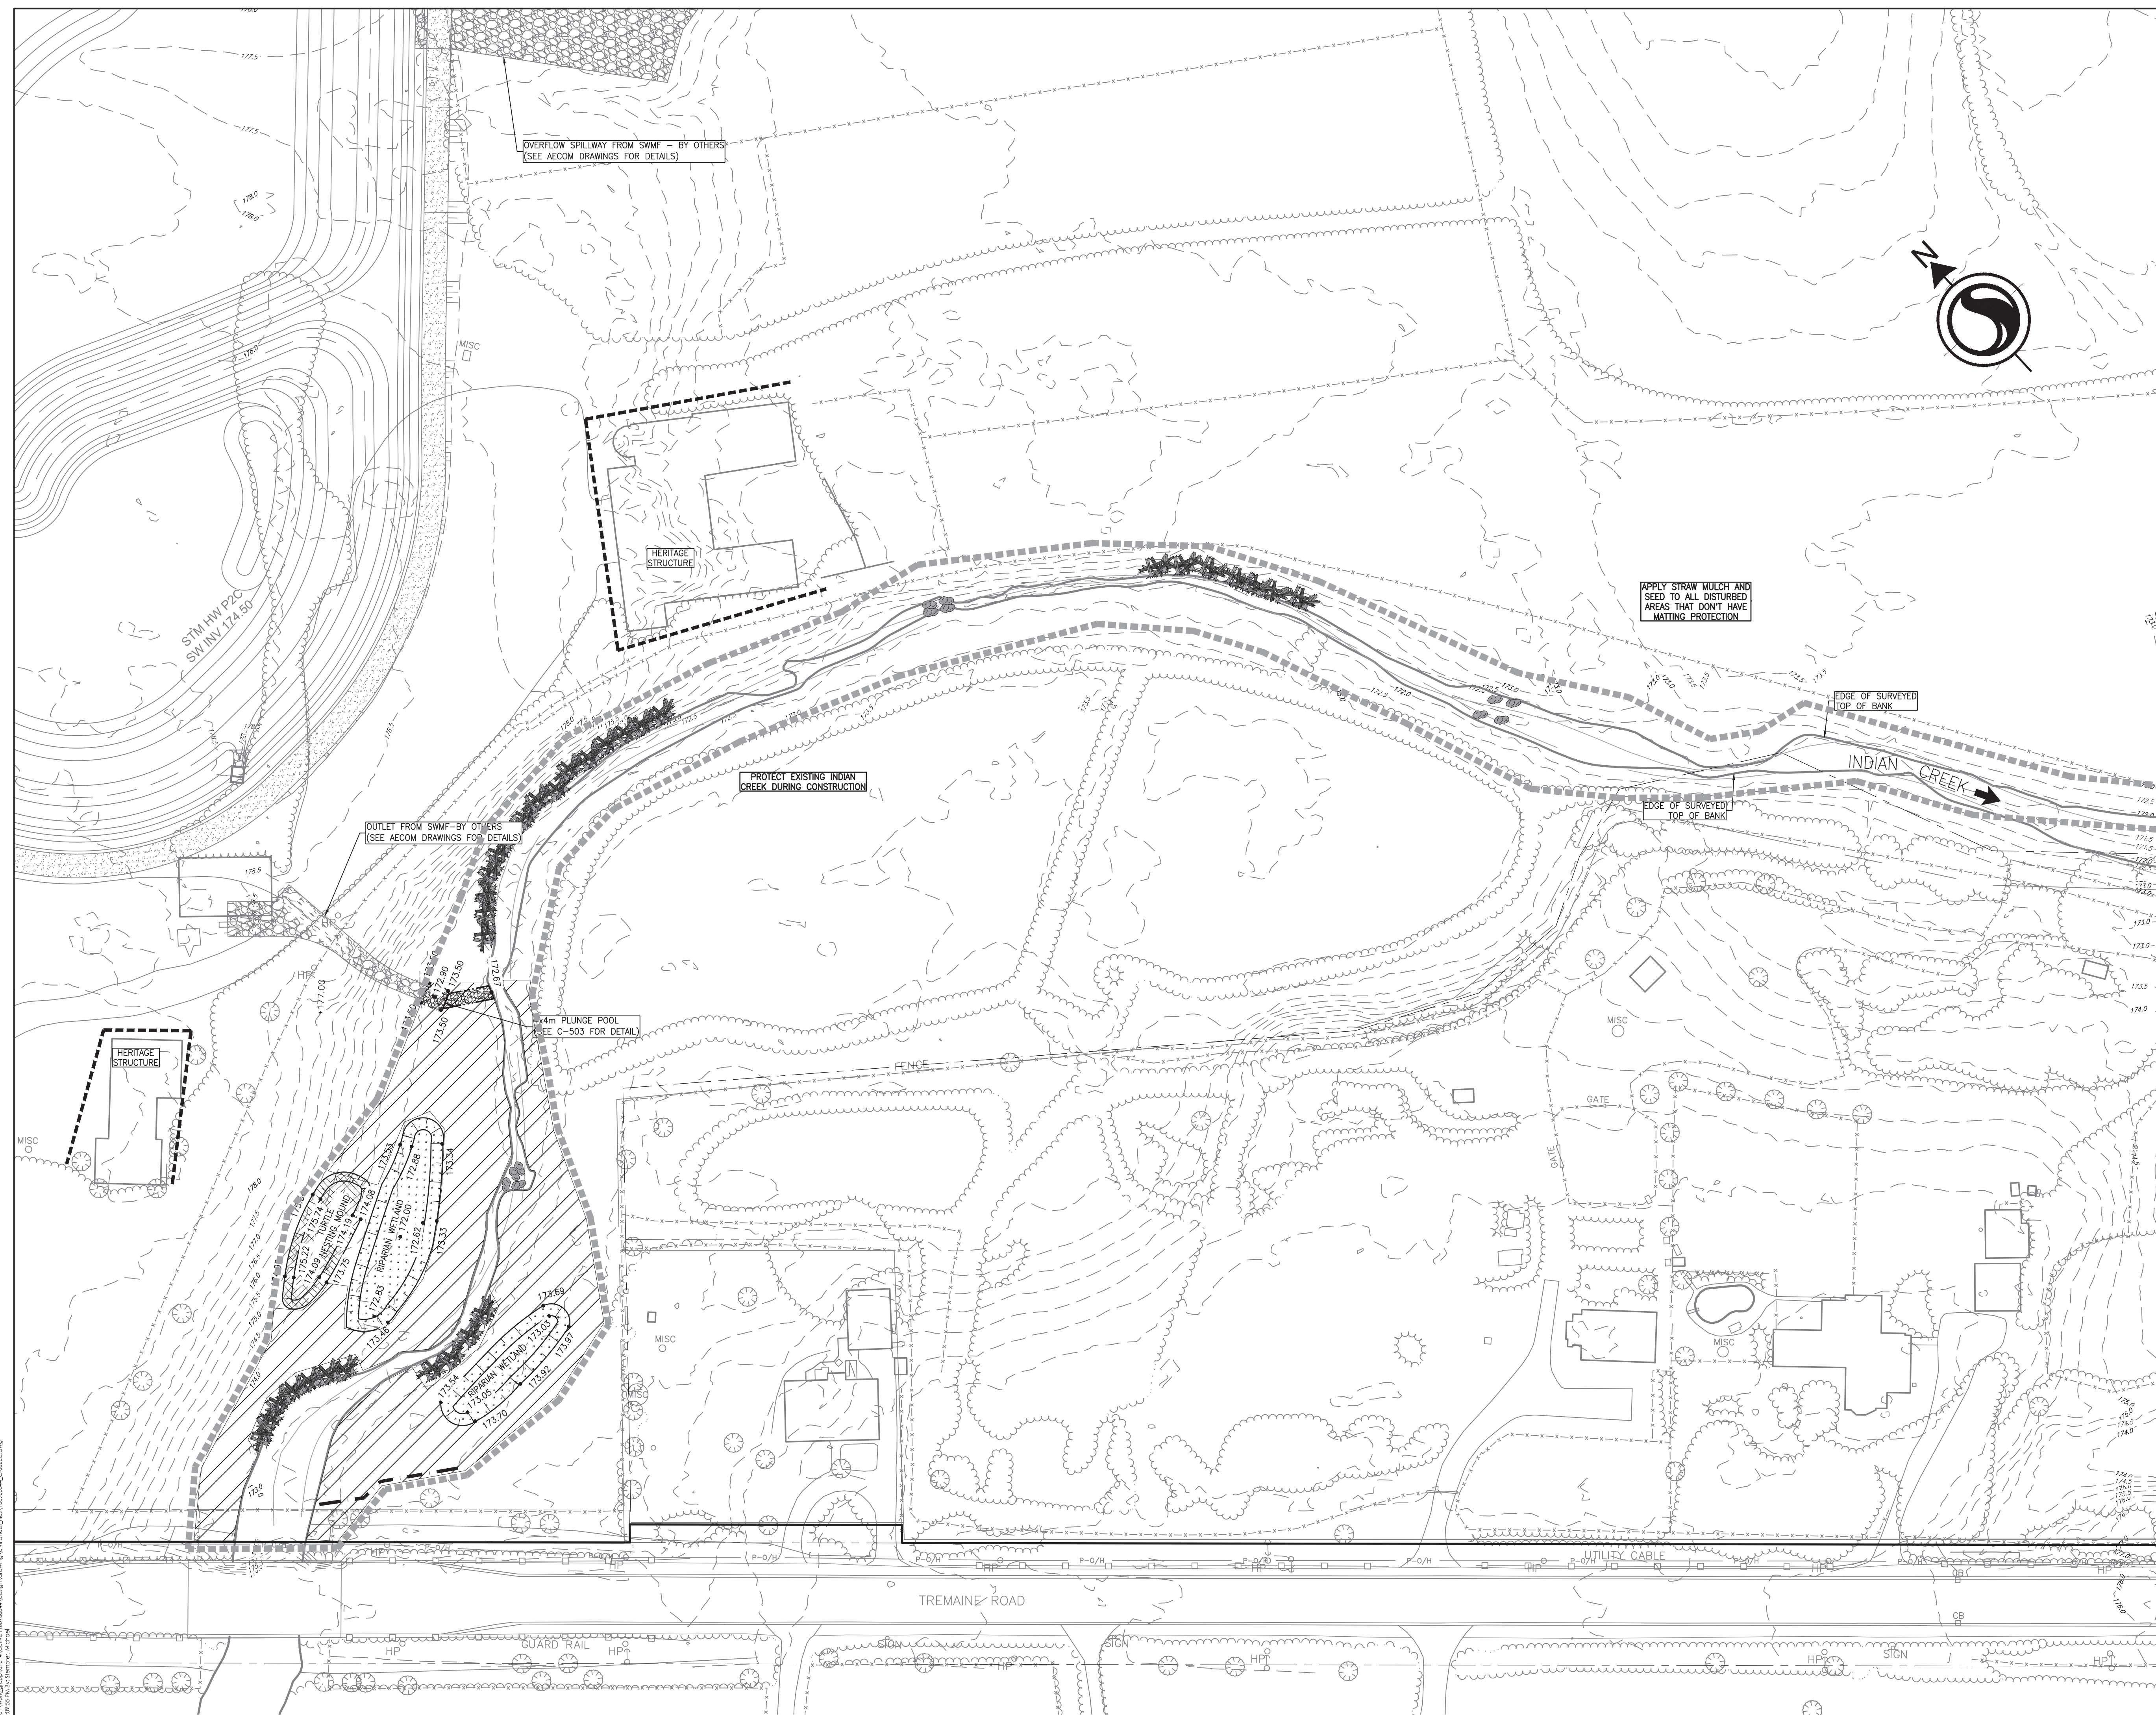
MILTON LOGISTICS HUB - NATURAL CHANNEL DESIGN FOR INDIAN CREEK AND TRIBUTARY A

Milton, ON

Title
 UPPER INDIAN CREEK
 SEDIMENT AND EROSION
 CONTROL PLAN

Project No.	160960844	Scale	1:500
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Revision	0	Sheet	15 of 29	Drawing No.	01-C-602
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